

PENRITH CITY COUNCIL AREA MR629 ERSKINE PARK ROAD

EXPLORERS WAY PROPOSED INTERSECTION UPGRADE

PART 1 CONCEPT DESIGN





LOCALITY PLAN

DISCIPLINE INDEX

CODE	DISCIPLINE
CDR-000	GENERAL
CDR-100	ROAD ALIGNMENT AND DETAIL
CDR-200	UTILITIES
CDR-300	STORM WATER MANAGEMENT
CDR-400	PAVEMENT
CDR-600	ROADSIDE FURNITURE AND LINEMARKING

NOT FOR CONSTRUCTION

₹ %								
H.	DRAWING FILE LOCATION / NAME	DESIGN LOT CODE	DESIGN MODEL FILE(S) USED FOR DOCUMENTATION OF THIS DR	AWING	PLOT DATE / TIME PLOT BY	CLIENT	PENRITH CITY COUNCIL AREA	٨3
PR 25	J:\110157R\01_CDR - Concept Plans\Part 1 - Explorers Way\110157-CDR-001.dwg				14/08/2015 4:45:12 PM rsilva		MR629 ERSKINE PARK ROAD	A3
B &	PREPARED BY DESIGNED	D	REVIEWED	VERIFIED	RMS PROJECT MANAGER	Transport	EXPLORERS WAY PRO	POSED
MAY	J. WYNDHAM PRINCE		total the A		NAME	NSW Roads & Maritir	INTERSECTION UPGRA	DE
SING.	CONSULTING CIVIL INFRASTRUCTURE ENGINEERS SIGNED	1	SIGNED	SIGNED	DATE		RMS PROJECT No. D	DESIGN PROJECT No. SHEET OF
DRAW	LEVEL 1, 77 UNION ROAD	R.A.S	NAME P.S	NAME	VALIDATION AND ACCEPTANCE OF THESE DRAWINGS AND THE DESIGN SHOWN	PREPARED FOR	RMS REGISTRATION No. DS2015/0	002541 PART 1
THIS 0	PENRITH NSW 2750 P (02) 4720 3000 E jwp@jwprince.com.au DATE		DATE		THEREON IS TO BE CARRIED OUT UNDER SEPARATE PROCESS		ISSUE STATUS E	SDMS No. SHEET No. CDR-001 B
								© Roads and Maritime Services

ING MAY BE PREPARED IN COLOUR AND MAY BE INCOMPLETE IF COPIED

115 120 125 130 135 140 145 150mm ON A3 SIZE ORIGINAL


AMENDMENT REGISTER

AMENDMENT REGISTER

AMENDMENT No.	SHEET Nos.	DESCRIPTION OF REVISION	AUTHORISED BY	DATE	AMENDMENT No.	SHEET Nos.	DESCRIPTION OF REVISION	AUTHORISED BY	DATE
Α	ALL	FINAL ISSUE FOR STAKEHOLDER REVIEW	P.S	23/06/2015					
В	ALL	FINAL ISSUE	P.S	14/08/2015					

3																_
	DRAWING FILE LOCATION / NAME J:\110157R\01_CDR - Concept Plans\Part 1 - Explorers Way\110157-CDR-00	2.dwg		DESIGN LO	OT CODE	DESIGN MODEL FILE(S) USED FOR DOCUMENTATION OF THI	S DRAWING	14/08/2015 4:		ot by i lva	CLIENT		PENRITH CITY COUNCIL AREA MR629 ERSKINE PARK ROAD		А	ر3
00	EXTERNAL REFERENCE FILES	REV DATE	AMENDMENT / REVISION DESCRIPTION	WVR No.	APPROVAL	SCALES ON A3 SIZE DRAWING	DRAWINGS / DESIGN PREPARED BY	TITLE	NAME	DATE		Transport	EXPLORERS WAY PROPOSED			
.,		A 23/06/20	15 FINAL ISSUE FOR STAKEHOLDER REVIEW		P.S.		J. WYNDHAM PRINCE	DRAWN	R.C			7 - 1 - 1 - 1 - 1 - 1 - 1 - 1 - 1 - 1 -	INTERSECTION UPGRADE			
15		B 14/08/20	15 FINAL ISSUE		P.S.			DRG CHECK				Services	AMENDMENT REGISTER			
9				1	1		CONSULTING CIVIL INFRASTRUCTURE ENGINEERS & PROJECT MANAGERS	DESIGN	R.A.S			. 33. 1,333		SHEET	OF	
	1			1	1		LEVEL 1, 77 UNION ROAD	DESIGN CHECK	P.S		PREPARED FOR	₹	RMS REGISTRATION No. DS2015/00254	.1	PA 1	ιRT
2	{			1		CO-ORDINATE SYSTEM HEIGHT DATUM	PENRITH NSW 2750	DESIGN MNGR					ISSUE STATUS EDMS No.		IS	SUI
0						MGA ZONE 56 AHD	P (02) 4720 3000 E jwp@jwprince.com.au	PROJECT MNGR						SHEET No.)02 E	3



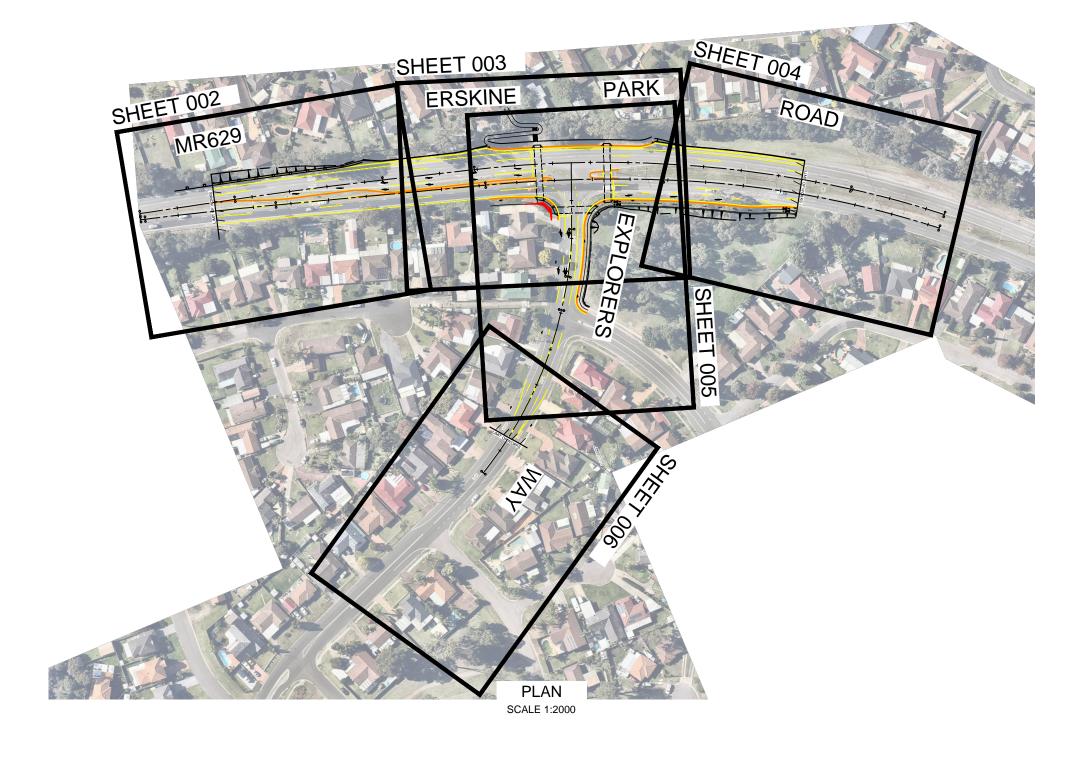

-	DRAWING FILE LOCATION / NAME				DESIGN LO	T COPE 10	DESIGN MODEL FILE(S) USED FOR DOCUMENTATION OF THIS		PLOT DATE / TIME			CLIENT		PENRITH CITY COUNCIL AREA		Δ3
7 5	J:\110157R\01_CDR - Concept Plans\Part 1 - Explorers Way\110157-CDR-0	03.dwg		1	:2000 (AT A3	3)			14/08/2015 4:4	45:29 PM rsilva				MR629 ERSKINE PARK ROAD		73
щ e	EXTERNAL REFERENCE FILES	REV I	DATE	AMENDMENT / REVISION DESCRIPTION	WVR No.	APPROVAL	SCALES ON A3 SIZE DRAWNS€RES	DRAWINGS / DESIGN PREPARED BY	TITLE	NAME DA	ATE	- AMb	Transport	EXPLORERS WAY PROPOSED		
4Y 1		A 2	3/06/2015	FINAL ISSUE FOR STAKEHOLDER REVIEW		P.S.		L MANADUAM DDINGE	DRAWN	R.C			1	INTERSECTION UPGRADE		
T 5 M		B 1	4/08/2015	FINAL ISSUE	1 '	P.S.		J. WYNDHAM PRINCE	DRG CHECK			NSW	Roads & Maritime Services	SITE PLAN & LOCALITY PLAN		
VIIV					'			CONSULTING CIVIL INFRASTRUCTURE ENGINEERS & PROJECT MANAGERS	DESIGN	R.A.S		entrantal.	7 301 7 303		SHEET OF	F
₹ —					1 '				DESIGN CHECK	P.S		PREPARED FOR		RMS REGISTRATION No. DS2015/002541		PART 1
ر ا					1 '		CO-ORDINATE SYSTEM HEIGHT DATUM	PENRITH NSW 2750	DESIGN MNGR					ISSUE STATUS EDMS No.		ISSUE
Ĕ 。					1 '		MGA ZONE 56 AHD	P (02) 4720 3000 E jwp@jwprince.com.au	PROJECT MNGR					25	CDR-003	В
							-							© Roads	and Maritime Sei	rvices

INDEX

DRAWING NUMBER	DRAWING TITLE		ISSUE	SHEET
CDR-001	COVER		Α	
CDR-002	AMENDMENT REGISTER		Α	
CDR-003	SITE PLAN & LOCALITY PLAN		А	
CDR-004	INDEX		Α	
CDR-005	EXPLORERS WAY	TYPICAL SECTIONS	Α	1
CDR-006	EXPLORERS WAY	TYPICAL SECTIONS	Α	2
CDR-007	EXPLORERS WAY	TYPICAL SECTIONS	Α	3
CDR-101	ROAD DESIGN	MC01 - CH. 0 TO CH. 140	А	1
CDR-102	ROAD DESIGN - PLAN	MC01 - CH.140 TO CH. 280	А	2
CDR-103	ROAD DESIGN - PLAN	MC01 - CH. 280 TO CH. 420	А	3
CDR-104	ROAD DESIGN - PLAN	MC20 - CH. 0 TO CH. 110	А	4
CDR-105	ROAD DESIGN - PLAN	MC20 - CH. 110 TO CH.180	А	5
CDR-106	ROAD DESIGN - PLAN	MC20 - CH. 110 TO CH.180	Α	6
CDR-201	UTILITIES	GENERAL NOTES & SUPP. DRAWINGS	А	1
CDR-202	UTILITIES - PLAN	MC01 - CH. 0 TO CH. 140	А	2
CDR-203	UTILITIES - PLAN	MC01 - CH.140 TO CH. 280	А	3
CDR-204	UTILITIES - PLAN	MC01 - CH. 280 TO CH. 420	А	4
CDR-205	UTILITIES - PLAN	MC20 - CH. 0 TO CH. 110	А	5
CDR-206	UTILITIES - PLAN	MC20 - CH. 110 TO CH.180	А	6
CDR-301	DRAINAGE	GENERAL NOTES & SUPP. DRAWINGS	А	1
CDR-302	DRAINAGE - PLAN	MC01 - CH. 0 TO CH. 140	А	2
CDR-303	DRAINAGE - PLAN	MC01 - CH.140 TO CH. 280	Α	3
CDR-304	DRAINAGE - PLAN	MC01 - CH. 280 TO CH. 420	А	4
CDR-305	DRAINAGE - PLAN	MC20 - CH. 0 TO CH. 110	А	5
CDR-306	DRAINAGE - PLAN	MC20 - CH. 110 TO CH.180	А	6
CDR-401	PAVEMENT & PAVEMENT TYPE	GENERAL NOTES & SUPP. DRAWINGS	Α	1
CDR-402	PAVEMENT - PLAN	MC01 - CH. 0 TO CH. 140	Α	2
CDR-403	PAVEMENT - PLAN	MC01 - CH.140 TO CH. 280	Α	3
CDR-404	PAVEMENT - PLAN	MC01 - CH. 280 TO CH. 420	Α	4
CDR-405	PAVEMENT - PLAN	MC20 - CH. 0 TO CH. 110	A	5
CDR-406	PAVEMENT - PLAN	MC20 - CH. 110 TO CH.180	A	6


INDEX


DRAWING NUMBER	DRAWING TITLE		ISSUE	SHEET
CDR-601	SIGNPOSTING & LINEMARKING	GENERAL NOTES & SUPP. DRAWINGS	А	1
CDR-602	SIGNPOSTING & LINEMARKING - PLAN	MC01 - CH. 0 TO CH. 140	А	2
CDR-603	SIGNPOSTING & LINEMARKING - PLAN	MC01 - CH.140 TO CH. 280	А	3
CDR-604	SIGNPOSTING & LINEMARKING - PLAN	MC01 - CH. 280 TO CH. 420	А	4
	SIGNPOSTING & LINEMARKING -			

NOT FOR CONSTRUCTION

© Roads and Maritime Services

<u>۾</u> ۾															
	DRAWING FILE LOCATION / NAME J:\110157R\01_CDR - Concept Plans\Part 1 - Explorers Way\110157-CDR-0	04.dwg			DESIGN L	LOT CODE	DESIGN MODEL FILE(S) USED FOR DOCUMENTATION OF THIS		PLOT DATE / TIM 14/08/2015 4		PLOT BY rsilva	CLIENT		PENRITH CITY COUNCIL AREA MR629 ERSKINE PARK ROAD	A3
H 0.	EXTERNAL REFERENCE FILES	REV	DATE	AMENDMENT / REVISION DESCRIPTION	WVR No.	APPROVAL	SCALES ON A3 SIZE DRAWING	DRAWINGS / DESIGN PREPARED BY	TITLE	NAME	DATE	4111	Transport	EXPLORERS WAY PROPOSED	
- ₹		Α	23/06/2015	FINAL ISSUE FOR STAKEHOLDER REVIEW		P.S.		L MAYNDHAM DDINGE	DRAWN	R.C			· · · · · · · · · · · · · · · · · · ·	INTERSECTION UPGRADE	
Σ Σ	4	В	14/08/2015	FINAL ISSUE		P.S.		J. WYNDHAM PRINCE	DRG CHECK			NSW	Roads & Maritime Services	INDEX	
Ĭ ₽								CONSULTING CIVIL INFRASTRUCTURE ENGINEERS & PROJECT MANAGERS	DESIGN	R.A.S			. 55. 7,555		SHEET OF
₹ -	1							LEVEL 1, 77 UNION ROAD	DESIGN CHECK	P.S		PREPARED FOR		RMS REGISTRATION No. DS2015/00254	1 PART
S ⊡	-					'	CO-ORDINATE SYSTEM HEIGHT DATUM	PENRITH NSW 2750	DESIGN MNGR					ISSUE STATUS EDMS No.	SHEET No. ISSUE
Ë 。					1	I '	MGA ZONE 56 AHD	P (02) 4720 3000 E jwp@jwprince.com.au	PROJECT MNGR			1			CDR-004 B

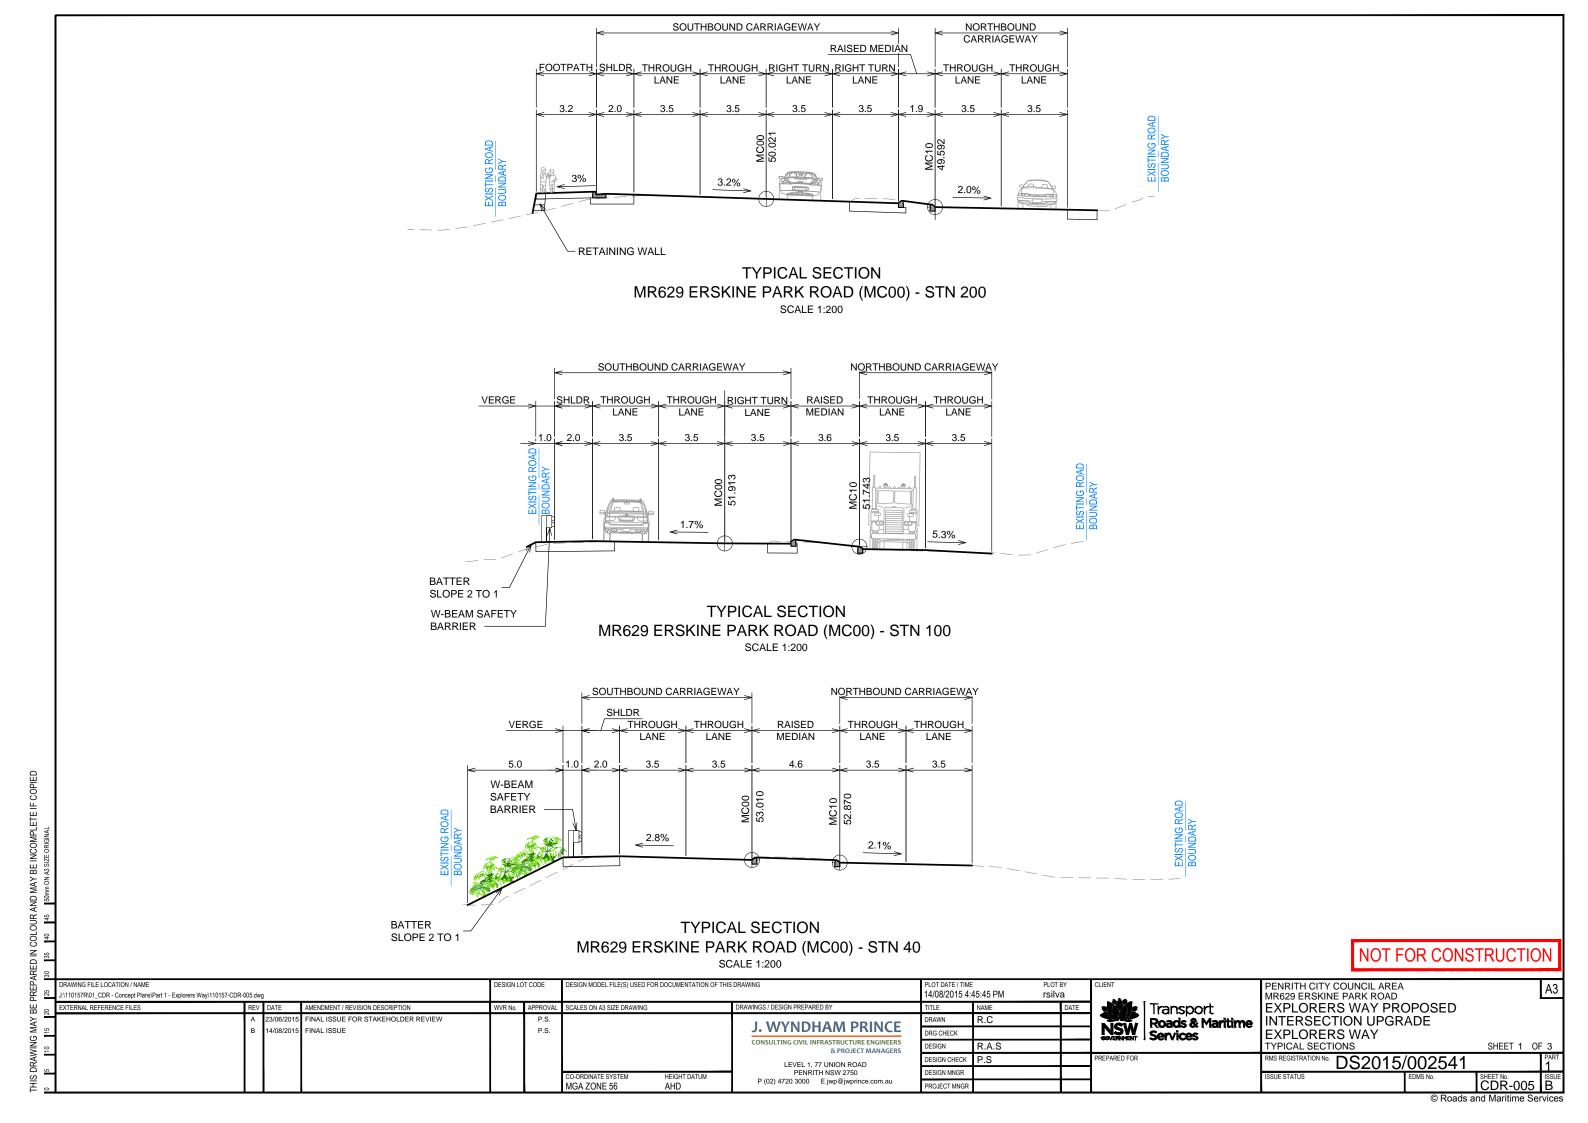

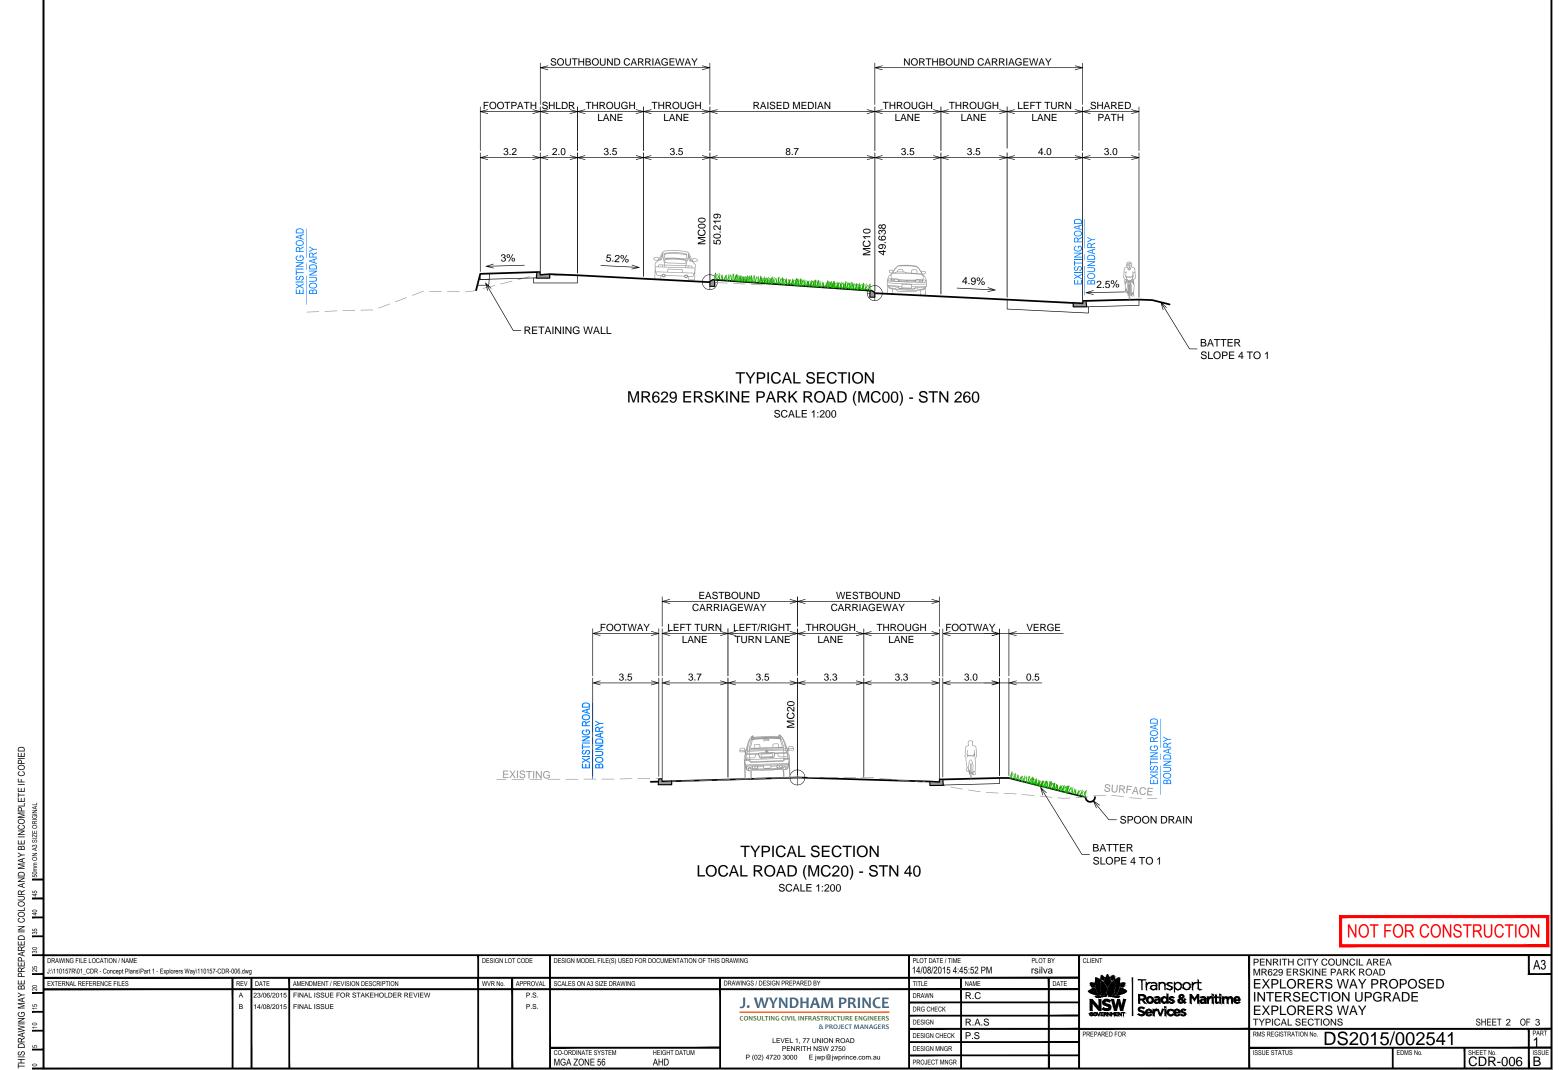

GENERAL NOTES


- ALL NEW WORKS ARE TO BE UNDERTAKEN TO THE REQUIREMENTS OF CURRENT RMS QA SPECIFICATION, PENRITH CITY COUNCIL & AUSTRALIAN STANDARDS UNLESS OTHERWISE STATED, MANDATORY COUNCIL INSPECTIONS ARE TO BE CARRIED OUT IN ACCORDANCE WITH COUNCIL'S WORK SPECIFICATIONS & THE RMS "WORKS AUTHORISATION DEED" RESPECTIVELY.
- ALL APPROVALS FOR TRAFFIC MANAGEMENT, STAGING AND CONSTRUCTION WORKS ARE TO BE OBTAINED PRIOR TO ANY SITE WORKS COMMENCING. SPECIFIC CONSTRUCTION STAGING TRAFFIC MANAGEMENT PLANS ARE REQUIRED TO BE PREPARED BY, AND APPROVED BY, AN RMS ACCREDITED SELECT/MODIFY OFFICER.
 - PROVISION FOR TRAFFIC DURING CONSTRUCTION TO BE IN ACCORDANCE WITH RMS SPECIFICATION G10.
- SOIL & WATER MANAGEMENT CONTROLS TO BE IMPLEMENTED IN ACCORDANCE WITH CURRENT RMS QA SPECIFICATION G38 & G39, DEPARTMENT OF ENVIRONMENT & CLIMATE CHANGE (DECC) & DEPARTMENT OF WATER & ENERGY (DWE) REQUIREMENTS. THE WORKS ARE TO BE IMPLEMENTED PRIOR TO & MAINTAINED DURING & AFTER THE CONSTRUCTION WORKS.
- ALL CO-ORDINATES ARE MGA GRID, LEVELS TO AHD. DETAIL SURVEY & CONTROLS BY SURVEY COMPANY, DATE RECEIVED, FILE #.
- ALL MEASUREMENTS ARE IN METRES UNLESS SHOWN OTHERWISE. KERBSIDE LANE WIDTH MEASURED FROM FACE OF KERB. NO INFORMATION IS TO BE SCALED FROM THESE DRAWINGS.
- ALL TRAFFIC, PEDESTRIAN & CYCLIST MOVEMENTS ARE TO BE MAINTAINED THROUGHOUT THE COURSE OF CONSTRUCTION.
- THE CONTRACTOR SHALL NOT ENTER UPON NOR DO ANY WORKS WITHIN ADJACENT LANDS WITHOUT PERMISSION OF THE OWNER, ROAD WORKS OUTSIDE EXISTING ROAD BOUNDARY TO BE NEGOTIATED WITH CURRENT LAND OWNERS OR AUTHORITIES.
- ONLY TREES DIRECTLY AFFECTED BY WORKS ARE TO BE REMOVED. COUNCIL CONDITIONS ARE TO BE COMPLIED WITH INCLUDING APPROVAL TO REMOVE TREE.
- EXISTING FENCING AND GATES TO BE RETAINED UNLESS OTHERWISE STATED. ACCESS IS TO BE MAINTAINED TO ALL ADJOINING PROPERTIES THROUGHOUT THE COURSE OF CONSTRUCTION.
- ALL DISTURBED AREAS ADJACENT TO THE WORKS TO BE TOPSOILED & (TURFED OR REVEGETATED) AS SPECIFIED.
- CONTRACTOR MUST:
 - MAKE SMOOTH JUNCTION WITH EXISTING CONDITIONS & ALL NEW WORKS
 - RECTIFY AT THE CONTRACTORS EXPENSE ANY DAMAGES CAUSED TO FENCING, PRIVATE PROPERTY OR EXISTING SERVICES & VERIFY ON SITE WITH AUTHORITY REPRESENTATIVES
 - RECTIFY ANY DAMAGE TO PRIVATE PROPERTY IN ACCORDANCE WITH COUNCIL'S SPECIFICATION
 - CLEARLY MARK & PROTECT ALL EXISTING SERVICES AT ALL TIMES DURING CONSTRUCTION
 - FOLLOW ALL UTILITY AUTHORITIES "DUTY OF CARE"

- UTILITY INFORMATION SHOWN ON THE PLANS DOES NOT DEPICT ANY MORE THAN THE PRESENCE OF A SERVICE, BASED ON AVAILABLE DOCUMENTARY EVIDENCE. THE PRESENCE OF A UTILITY SERVICE, ITS SIZE AND LOCATION SHOULD BE CONFIRMED BY FIELD INSPECTION, PRIOR TO THE COMMENCEMENT OF ROADWORKS AND THE RELEVANT UTILITY PLANS OBTAINED BY DIALLING PH 1100 OR FAX 1300 652 077 (DIAL BEFORE YOU DIG). CAUTION SHOULD BE EXERCISED WHEN WORKING IN THE VICINITY OF ALL UTILITY SERVICES.
- PAVEMENT MARKINGS THAT FORM NO PART OF THE FINAL WORKS ARE TO BE REMOVED BY WATER BLASTING OR OTHER METHOD AS APPROVED BY THE SUPERINTENDENT/PROJECT MANAGER.
- FOR DRAINAGE WORKS REFER DRG CDR-300 SERIES.
- FOR PAVEMENT WORKS REFER DRG CDR-400 SERIES.
- FOR PAVEMENT MARKINGS & SIGNPOSTING REFER DRG CDR-600 SERIES.

GENERAL SUPPLEMENTARY DRAWINGS

RMS SUPPLEMENTARY DRAWINGS	
STANDARD KERB AND GUTTER SHAPES	MD.R15.A01.A.1
KERB RAMPS	MD.R173.B01.A
TYPICAL APPLICATION OF KERB RAMPS AT INTERSECTIONS	MD.R173.A01.A
PAVEMENT LINEMARKING & DIMENSIONS	MD.R60.A01.A
PEDESTRIAN FENCE GENERAL	MD.R201.C01.A
PIPE HANDRAIL DETAIL	MD.R201.C20.A
POST & WIRE FENCE	MD.R201.A02.A
SECTION 16 - GUIDE POSTS & DELINEATION OF SAFETY BARRIERS	RMS DELINEATION GUIDE
RMS TCS PLAN - SOLDIERS PARADE(TCS 4632)	DS2014 / 004990
RMS TCS PLAN - MACDONLAD ROAD REALIGNMENT (TCS 4633)	DS2014 / 004991
LOCAL COUNCIL SUPPLEMENTARY DRAWINGS	
KERB AND GUTTERS (PENRITH CITY COUNCIL)	SD1003/1

	J:\110157R\01_CDR - Concept Plans\Part 1 - Explorers Way\110157-CDR-1	01.dwg		DESIGNE	JI CODE	DESIGN WODEL TIEE(S) OSED FOR DOCUMENTATION OF THIS	DIVAMINO	14/08/2015 4:		rsilva	CLILIVI		MR629 ERSKINE PARK ROAD			A3
2	EXTERNAL REFERENCE FILES	REV DATE	AMENDMENT / REVISION DESCRIPTION	WVR No.	APPROVAL	SCALES ON A3 SIZE DRAWING	DRAWINGS / DESIGN PREPARED BY	TITLE	NAME	DATE		Transport	EXPLORERS WAY PRO	POSED		
		A 23/06/2015	FINAL ISSUE FOR STAKEHOLDER REVIEW		P.S.		J. WYNDHAM PRINCE	DRAWN	R.C			Roads & Maritime	INTERSECTION UPGRA	√DE		l
15		B 14/08/2015	FINAL ISSUE		P.S.		J. WYNDHAM PRINCE	DRG CHECK			NSW.	Services	INTERSECTION UPGRA ROAD DESIGN			
10							CONSULTING CIVIL INFRASTRUCTURE ENGINEERS & PROJECT MANAGERS	DESIGN	R.A.S		- Constitution	. 46. 1,665	GENERAL NOTES & SUPP. DRAV	WINGS	SHEET 1 OF	F 6
							LEVEL 1, 77 UNION ROAD	DESIGN CHECK	P.S		PREPARED FOR		RMS REGISTRATION No. DS2015/0	002541		PART 1
2						CO-ORDINATE SYSTEM HEIGHT DATUM	PENRITH NSW 2750	DESIGN MNGR							SHEET No.	ISSUE
0						MGA ZONE 56 AHD	P (02) 4720 3000 E jwp@jwprince.com.au	PROJECT MNGR							CDR-101	В
														© Roads a	and Maritime Sei	rvices

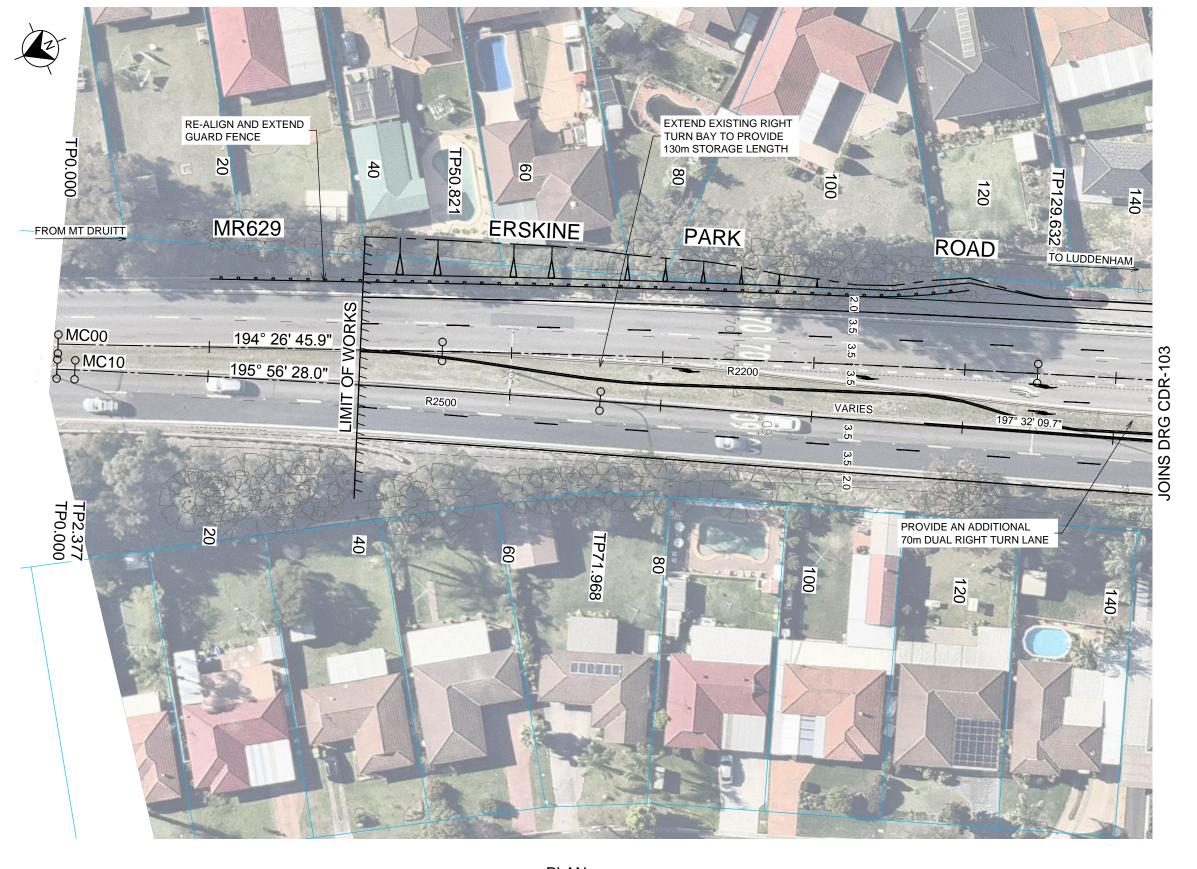

PLAN SCALE 1:500

PLAN LEGEND

PROPOSED PROPERTY ACQUISITION APPROX. 15.0 m² EXISTING ELECT. U/GRND LINE EXISTING GAS MAIN EXISTING OPTICAL FIBRE ABOVE GROUND

EXISTING TELSTRA LINE

EXISTING SEWER MAIN EXISTING WATER MAIN

STOP VALVE WATER HYDRANT TRAFFIC SIGNAL BOX LIGHT POLE GAS PIPELINE MARK GAS VALVE STORMWATER DRAINAGE PIT STORMWATER JUNCTION PIT POWER POLE TELEPHONE **TRANSFORMER** TELEPHONE & POWER POLE

REFER TO RMS SURVEY LEGEND FOR MORE DETAILS

GAS VALVE BOX

NOTES


- REFER TO SHEET CDR-101 FOR PLAN GENERAL NOTES & SUPPLEMENTARY DRAWINGS
- 2. REFER TO SHEET CDR-201 FOR UTILITY GENERAL NOTES & SUPPLEMENTARY DRAWINGS
- 3. ALL OVERHEAD & UNDERGROUND UTILITIES ARE TO BE RETAINED UNAFFECTED UNLESS OTHERWISE NOTED
- ACCESS TO ALL ADJOINING PROPERTY MUST BE MAINTAINED THROUGHOUT DURATION OF THE
- MAINTAIN ALL EXISTING DRIVEWAYS AND ACCESSES.
- FINAL ACQUISITION BOUNDARY SUBJECT TO INVESTIGATION SURVEY AND DESIGN.

DS2015/002541

NOT FOR CONSTRUCTION

PLOT DATE / TIME 14/08/2015 4:46:13 PM PENRITH CITY COUNCIL AREA MR629 ERSKINE PARK ROAD EXPLORERS WAY PROPOSED 110157R\01_CDR - Concept Plans\Part 1 - Explorers Way\110157-CDR-102.dw rsilva Transport FINAL ISSUE FOR STAKEHOLDER REVIEW INTERSECTION UPGRADE Roads & Maritime J. WYNDHAM PRINCE NSW P.S. INAL ISSUE ROAD DESIGN - PLAN MC01 - CH. 0 TO CH. 140 SCALE 1:500m Services CONSULTING CIVIL INFRASTRUCTURE ENGINEERS DESIGN R.A.S & PROJECT MANAGERS DESIGN CHECK P.S REPARED FOR LEVEL 1, 77 UNION ROAD DESIGN MNGR PENRITH NSW 2750 ISSUE STATUS HEIGHT DATUM P (02) 4720 3000 E jwp@jwprince.com.au MGA ZONE 56 AHD

SHEET 2 OF 6

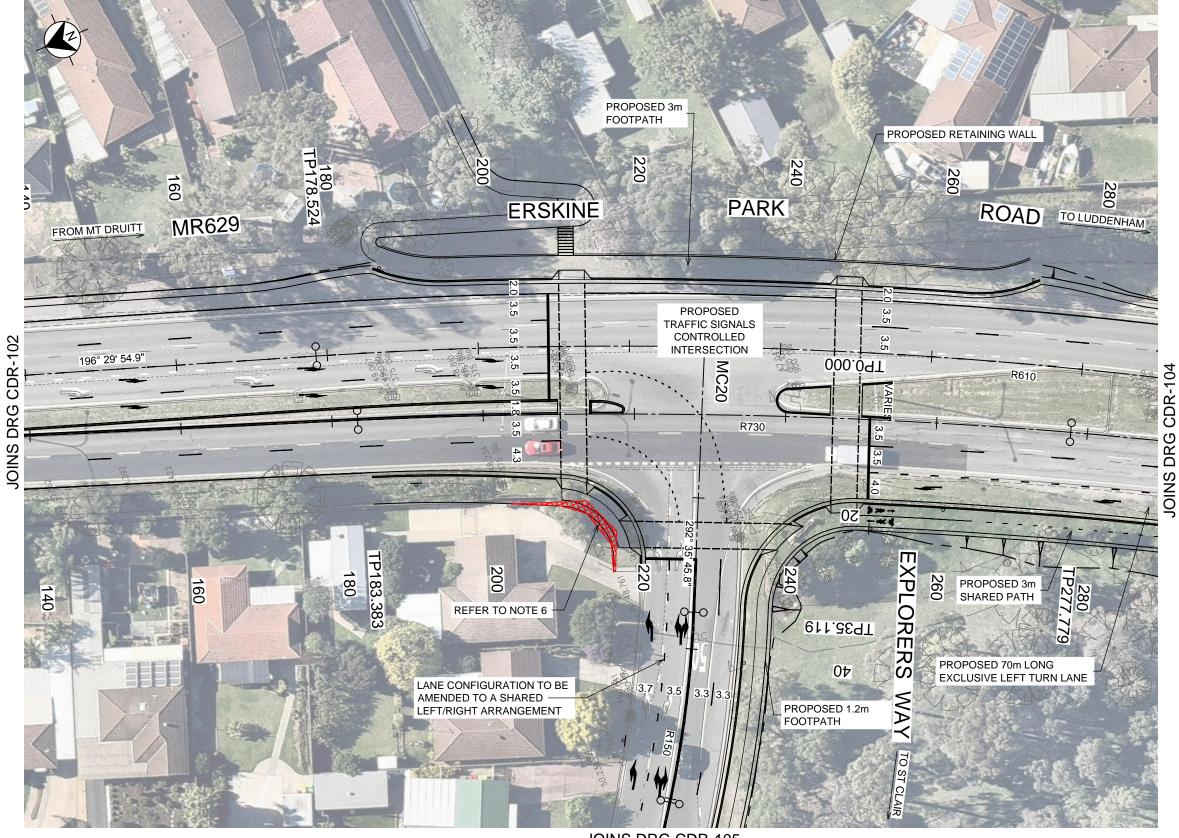

JOINS DRG CDR-105

PLAN

SCALE 1:500

PLAN LEGEND

PROPOSED PROPERTY ACQUISITION APPROX. 15.0 m² EXISTING ELECT. U/GRND LINE EXISTING GAS MAIN EXISTING OPTICAL FIBRE ABOVE GROUND EXISTING TELSTRA LINE EXISTING SEWER MAIN EXISTING WATER MAIN STOP VALVE WATER HYDRANT TRAFFIC SIGNAL BOX LIGHT POLE

GAS PIPELINE MARK

STORMWATER JUNCTION PIT POWER POLE

TRANSFORMER

& POWER POLE

GAS VALVE BOX

REFER TO RMS SURVEY LEGEND FOR MORE DETAILS

GAS VALVE STORMWATER DRAINAGE PIT

TELEPHONE

TELEPHONE

NOTES


- REFER TO SHEET CDR-101 FOR PLAN GENERAL NOTES & SUPPLEMENTARY DRAWINGS
- 2. REFER TO SHEET CDR-201 FOR UTILITY GENERAL NOTES & SUPPLEMENTARY DRAWINGS
- ALL OVERHEAD & UNDERGROUND UTILITIES ARE TO BE RETAINED UNAFFECTED UNLESS OTHERWISE NOTED
- ACCESS TO ALL ADJOINING PROPERTY MUST BE MAINTAINED THROUGHOUT DURATION OF THE
- MAINTAIN ALL EXISTING DRIVEWAYS AND ACCESSES.
- FINAL ACQUISITION BOUNDARY SUBJECT TO INVESTIGATION SURVEY AND DESIGN.

NOT FOR CONSTRUCTION

SHEET 3 OF 6

© Roads and Maritime Services

PLOT DATE / TIME 14/08/2015 4:46:29 PM PENRITH CITY COUNCIL AREA MR629 ERSKINE PARK ROAD EXPLORERS WAY PROPOSED 110157R\01_CDR - Concept Plans\Part 1 - Explorers Way\110157-CDR-103.dw rsilva Transport FINAL ISSUE FOR STAKEHOLDER REVIEW INTERSECTION UPGRADE Roads & Maritime J. WYNDHAM PRINCE NSW P.S. INAL ISSUE ROAD DESIGN - PLAN MC01 - CH.140 TO CH. 280 SCALE 1:500m Services CONSULTING CIVIL INFRASTRUCTURE ENGINEERS DESIGN R.A.S & PROJECT MANAGERS DESIGN CHECK P.S REPARED FOR DS2015/002541 LEVEL 1, 77 UNION ROAD DESIGN MNGR PENRITH NSW 2750 ISSUE STATUS HEIGHT DATUM P (02) 4720 3000 E jwp@jwprince.com.au MGA ZONE 56

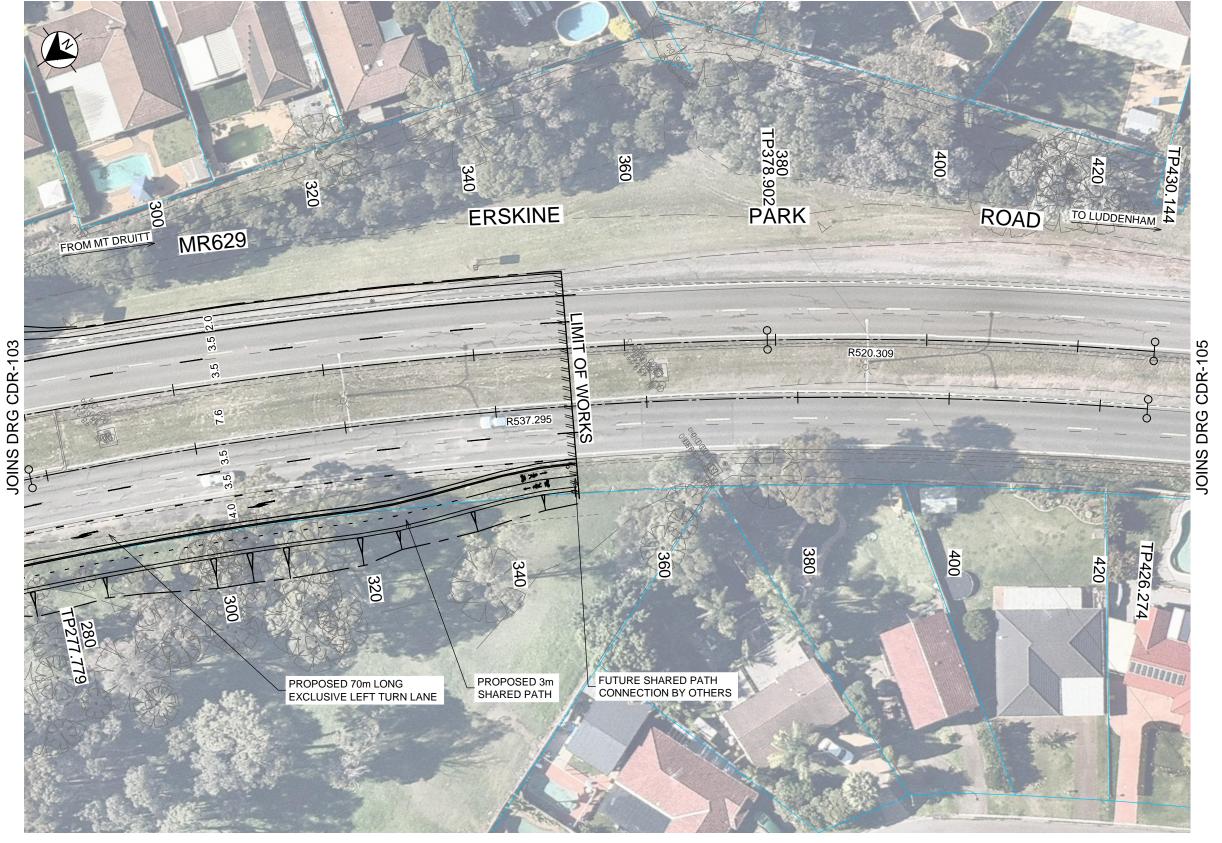

PLAN SCALE 1:500

PLAN LEGEND

ABOVE GROUND

EXISTING TELSTRA LINE

SZ -----S: EXISTING SEWER MAIN

EXISTING WATER MAIN

GAS PIPELINE MARK

GAS VALVE

JB

STORMWATER
JUNCTION PIT

POWER POLE

GAS VALVE

STORMWATER
DRAINAGE PIT

TELEPHONE

TRANSFORMER & POWER POLE

TELEPHONE PIT

GAS VALVE BOX

REFER TO RMS SURVEY LEGEND FOR MORE DETAILS

NOTES


- REFER TO SHEET CDR-101 FOR PLAN GENERAL NOTES & SUPPLEMENTARY DRAWINGS
- 2. REFER TO SHEET CDR-201 FOR UTILITY
 GENERAL NOTES & SUPPLEMENTARY DRAWINGS
- 3. ALL OVERHEAD & UNDERGROUND UTILITIES ARE TO BE RETAINED UNAFFECTED UNLESS OTHERWISE NOTED
- 4. ACCESS TO ALL ADJOINING PROPERTY MUST BE MAINTAINED THROUGHOUT DURATION OF THE WORKS
- 5. MAINTAIN ALL EXISTING DRIVEWAYS AND ACCESSES.
- FINAL ACQUISITION BOUNDARY SUBJECT TO INVESTIGATION SURVEY AND DESIGN.

NOT FOR CONSTRUCTION

PLOT DATE / TIME 14/08/2015 4:46:49 PM PENRITH CITY COUNCIL AREA MR629 ERSKINE PARK ROAD EXPLORERS WAY PROPOSED 10157R\01_CDR - Concept Plans\Part 1 - Explorers Way\110157-CDR-104.dw rsilva Transport FINAL ISSUE FOR STAKEHOLDER REVIEW INTERSECTION UPGRADE Roads & Maritime J. WYNDHAM PRINCE NSW P.S. FINAL ISSUE ROAD DESIGN - PLAN MC01 - CH. 280 TO CH. 420 SCALE 1:500m Services CONSULTING CIVIL INFRASTRUCTURE ENGINEERS SHEET 4 OF 6 DESIGN R.A.S & PROJECT MANAGERS DESIGN CHECK P.S DS2015/002541 LEVEL 1, 77 UNION ROAD PENRITH NSW 2750 DESIGN MNGR ISSUE STATUS HEIGHT DATUM P (02) 4720 3000 E jwp@jwprince.com.au MGA ZONE 56 AHD © Roads and Maritime Services

20 25 30 35 40 45 50mm ON A3 SIZE ORIGINAL

THIS DRAWING MAY BE PREPARED IN COLOUR AND MAY

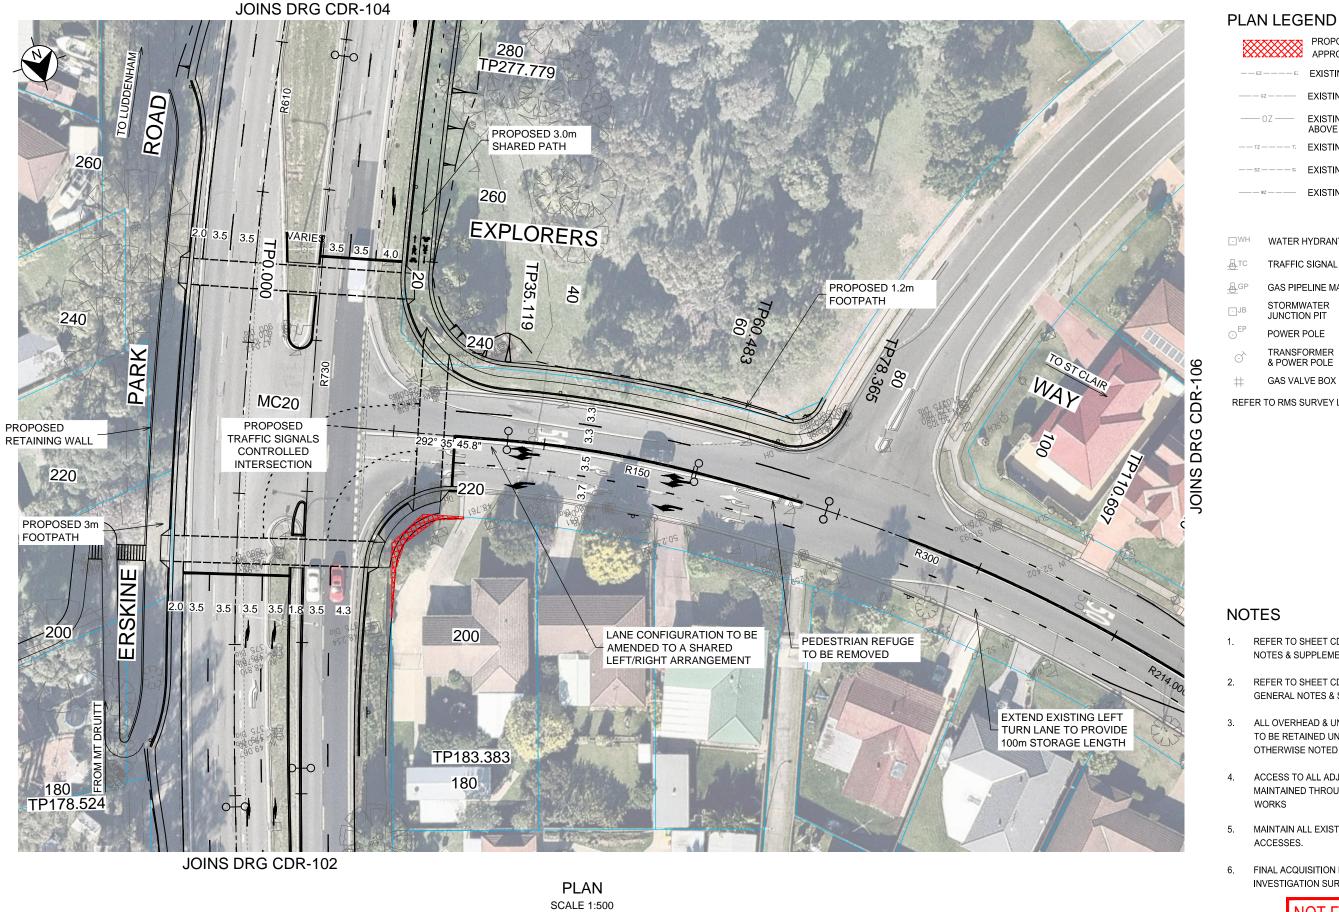

PROPOSED PROPERTY ACQUISITION APPROX. 15.0 m²

EXISTING ELECT. U/GRND LINE

EXISTING OPTICAL FIBRE ABOVE GROUND

EXISTING GAS MAIN

EXISTING TELSTRA LINE

EXISTING SEWER MAIN

STOP VALVE WATER HYDRANT

EXISTING WATER MAIN

TRAFFIC SIGNAL BOX LIGHT POLE GAS PIPELINE MARK GAS VALVE

> STORMWATER DRAINAGE PIT STORMWATER JUNCTION PIT POWER POLE TELEPHONE

TRANSFORMER TELEPHONE & POWER POLE

GAS VALVE BOX

REFER TO RMS SURVEY LEGEND FOR MORE DETAILS

NOTES

- REFER TO SHEET CDR-101 FOR PLAN GENERAL **NOTES & SUPPLEMENTARY DRAWINGS**
- REFER TO SHEET CDR-201 FOR UTILITY GENERAL NOTES & SUPPLEMENTARY DRAWINGS
- ALL OVERHEAD & UNDERGROUND UTILITIES ARE TO BE RETAINED UNAFFECTED UNLESS OTHERWISE NOTED
- ACCESS TO ALL ADJOINING PROPERTY MUST BE MAINTAINED THROUGHOUT DURATION OF THE
- MAINTAIN ALL EXISTING DRIVEWAYS AND ACCESSES.
- FINAL ACQUISITION BOUNDARY SUBJECT TO INVESTIGATION SURVEY AND DESIGN.

NOT FOR CONSTRUCTION

PLOT DATE / TIME 14/08/2015 4:47:06 PM PENRITH CITY COUNCIL AREA MR629 ERSKINE PARK ROAD EXPLORERS WAY PROPOSED 110157R\01_CDR - Concept Plans\Part 1 - Explorers Way\110157-CDR-105.dv rsilva Transport FINAL ISSUE FOR STAKEHOLDER REVIEW INTERSECTION UPGRADE Roads & Maritime J. WYNDHAM PRINCE NSW P.S. INAL ISSUE ROAD DESIGN - PLAN MC20 - CH. 0 TO CH. 110 SCALE 1:500m Services CONSULTING CIVIL INFRASTRUCTURE ENGINEERS SHEET 5 OF 6 DESIGN R.A.S & PROJECT MANAGERS DESIGN CHECK P.S REPARED FOR DS2015/002541 LEVEL 1, 77 UNION ROAD DESIGN MNGR PENRITH NSW 2750 ISSUE STATUS HEIGHT DATUM P (02) 4720 3000 E jwp@jwprince.com.au MGA ZONE 56 AHD © Roads and Maritime Services



PLAN SCALE 1:500

PLAN LEGEND

PROPOSED PROPERTY ACQUISITION
APPROX. 15.0 m²

EXISTING ELECT. U/GRND LINE

EXISTING GAS MAIN

—— 0Z —— EXISTING OPTICAL FIBRE ABOVE GROUND

--sz---s EXISTING TELSTRA LINE
--sz---s EXISTING SEWER MAIN

——— wz ——— EXISTING WATER MAIN

WATER HYDRANT △ STOP VALVE

TRAFFIC SIGNAL BOX ※ LIGHT POLE

GAS PIPELINE MARK △ GAS VALVE

STORMWATER
JUNCTION PIT □ STORMWATER
DRAINAGE PIT

DEP POWER POLE □ TPL TELEPHONE

POWER POLE

TRANSFORMER & POWER POLE

TELEPHONE PIT

GAS VALVE BOX

REFER TO RMS SURVEY LEGEND FOR MORE DETAILS

NOTES

- REFER TO SHEET CDR-101 FOR PLAN GENERAL
 NOTES & SUPPLEMENTARY DRAWINGS
- 2. REFER TO SHEET CDR-201 FOR UTILITY
 GENERAL NOTES & SUPPLEMENTARY DRAWINGS
- ALL OVERHEAD & UNDERGROUND UTILITIES ARE
 TO BE RETAINED UNAFFECTED UNLESS
 OTHERWISE NOTED
- 4. ACCESS TO ALL ADJOINING PROPERTY MUST BE MAINTAINED THROUGHOUT DURATION OF THE WORKS
- 5. MAINTAIN ALL EXISTING DRIVEWAYS AND ACCESSES.
- FINAL ACQUISITION BOUNDARY SUBJECT TO INVESTIGATION SURVEY AND DESIGN.

	06.dwg			DESIGN LC	OT CODE	DESIGN MODEL FILE(S) USED FOR DOCUMENTATION OF THIS				rsilva					A3
EXTERNAL REFERENCE FILES	REV	DATE	AMENDMENT / REVISION DESCRIPTION	WVR No.	APPROVAL	SCALES ON A3 SIZE DRAWING	DRAWINGS / DESIGN PREPARED BY	TITLE	NAME	DATE		Transport			
					P.S.	0 5 10 15 20	I WANDHAM DDINGE	DRAWN	R.C			Roads & Maritime	INTERSECTION UPGRA	ADE	
	В	14/08/2015	FINAL ISSUE		P.S.	SCALE 1:500m		DRG CHECK			NSW.	Services	ROAD DESIGN - PLAN		
								DESIGN	R.A.S			. 55. 1,555	MC20 - CH. 110 TO CH.180		SHEET 6 OF 6
								DESIGN CHECK	P.S		PREPARED FOR		RMS REGISTRATION No. DS2015/	002541	PART 1
						CO-ORDINATE SYSTEM HEIGHT DATUM	PENRITH NSW 2750	DESIGN MNGR							SHEET No. ISSUE
						MGA ZONE 56 AHD	P (02) 4720 3000 E jwp@jwprince.com.au	PROJECT MNGR						ESINO NO.	SHEET No. ISSUE B
,		EXTERNAL REFERENCE FILES REV A	J\110157R\01_CDR - Concept Plans\Part 1 - Explorers Way\110157-CDR-106.dwg EXTERNAL REFERENCE FILES REV DATE A 23/06/2015	J:\110157R\01_CDR - Concept Plans\Part 1 - Explorers Way\110157-CDR-106.dwg	3/110157R01_CDR - Concept PlansiPart 1 - Explorers Way\110157-CDR-106.dwg EXTERNAL REFERENCE FILES REV DATE AMENDMENT / REVISION DESCRIPTION WWR No.	3/11/0157R/01_CDR - Concept Plans Part 1 - Explorers Way110157-CDR-106.dwg	MITO157R01_CDR - Concept PlansiPart 1 - Explorers Way\110157-CDR-106.dwg	AMENDMENT / Explorers Way/110157-CDR-106.dwg EXTERNAL REFERENCE FILES REV DATE AMENDMENT / REVISION DESCRIPTION WR No. APPROVAL SCALES ON AS SIZE DRAWING A 23/06/2015 B 14/08/2015 FINAL ISSUE FOR STAKEHOLDER REVIEW FINAL ISSUE FINAL ISSUE FINAL ISSUE P.S. P.S. D 5 10 15 20 SCALE 1:500m J. WYNDHAM PRINCE CONSULTING CIVIL INFRASTRUCTURE ENGINEERS & PROJECT MANAGERS LEVEL 1, 77 UNION ROAD PENRITH NSW 2750 CO-ORDINATE SYSTEM HEIGHT DATUM R (23/147/2) 2000 Filing (illuminons com all intercence of the province of the propriet of the province of the	AMIDIOTOR Concept PlansiPart 1 - Explorers Way\110157-CDR-106.dwg EXTERNAL REFERENCE FILES REV DATE AMENDMENT / REVISION DESCRIPTION W/R No. APPROVAL SCALES ON A3 SIZE DRAWING A 23/06/2015 B 14/08/2015 FINAL ISSUE FOR STAKEHOLDER REVIEW FINAL ISSUE FINAL ISSUE P.S. P.S. O 5 10 15 20 SCALE 1:500m DRAWINGS / DESIGN PREPARED BY TITLE DRAWIN DRAWINGS / DESIGN PREPARED BY DRAWIN DRAWINGS / DESIGN PREPARED BY DRAWIN DRA	AMIDIOTOR Concept PlansiPart 1 - Explorers Way/110157-CDR-106.dwg EXTERNAL REFERENCE FILES REV DATE AMENDMENT / REVISION DESCRIPTION WR No. APPROVAL SCALES ON A3 SIZE DRAWING A 23/06/2015 FINAL ISSUE FOR STAKEHOLDER REVIEW FINAL ISSUE FINAL ISSUE	AMINIO157R01_CDR - Concept Plans/Part 1 - Explorers Way/110157-CDR-106.dwg EXTERNAL REFERENCE FILES REV DATE AMENDMENT / REVISION DESCRIPTION WR No. APPROVAL SCALES ON A3 SIZE DRAWING DRAWINGS / DESIGN PREPARED BY TITLE NAME DATE DRAWIN R.C. P.S. P.S. P.S. DRAWINGS / DESIGN PREPARED BY TITLE NAME DRAWIN R.C. DESIGN R.A.S. DESIGN CHECK P.S. DESIGN CHECK P.S. DESIGN NIGR DESIGN OF DESIGN PREPARED BY TITLE NAME DRAWIN R.C. DRAWIN R.C. DESIGN R.A.S. DESIGN CHECK P.S. DESIGN NIGR DESIGN NIGR	AMINIO157R01_CDR - Concept PlansiPart 1 - Explorers Way/110157-CDR-106.dwg EXTERNAL REFERENCE FILES REV DATE AMENDMENT / REVISION DESCRIPTION WW No. APPROVAL SCALES ON A3 SIZE DRAWING DRAWINGS / DESIGN PREPARED BY TITLE NAME DATE DRAWINGS / DESIGN PREPARED BY TITLE NAME DATE DRAWING R.C. DESIGN R.A.S. DESIGN R.A.S. DESIGN CHECK P.S. DESIGN MINGR DESIGN MINGR	AMIDIOTOR Concept PlansiPart 1 - Explorers Way/10157-CDR-106.dwg EXTERNAL REFERENCE FILES REV DATE AMENDMENT / REVISION DESCRIPTION WKN No. APPROVAL SCALES ON A3 SIZE DRAWING DRAWINGS / DESIGN PREPARED BY TITLE NAME DATE OR NAME OR NA	AMINIO157R01_CDR-Concept PlansPart 1 - Explorers Way/110157-CDR-106.dwg EXTERNAL REFERENCE FILES REV DATE AMENDMENT / REVISION DESCRIPTION A 23/06/2015 B 14/08/2015 FINAL ISSUE FOR STAKEHOLDER REVIEW FINAL ISSUE FINAL ISSUE FINAL ISSUE A 24/08/2015 FINAL ISSUE FINAL ISSU	### Project Navy/10157/cDr-10cdeyt Plans/Part 1 - Explorers Way/110157/cDr-106.dwg EXTERNAL REFERENCE FILES REV DATE AMENDMENT / REVISION DESCRIPTION WVR No. APPROVAL SCALES ON AS SIZE DRAWING DESCRIPTION TITLE NAME DATE AMENDMENT / REVISION DESCRIPTION PREPARED BY ### Project Hans/Part 1 - Explorers Way/110157/CDr-106.dwg EXTERNAL REFERENCE FILES REV DATE AMENDMENT / REVISION DESCRIPTION WVR No. APPROVAL SCALES ON AS SIZE DRAWING DATE NAME DATE DATE DATE NAME DATE DATE DATE NAME DATE DATE NAME DATE DATE NAME DATE DATE DATE NAME DATE DATE DATE NAME DATE DATE DATE DATE DATE DATE DATE DAT

PAVEMENT MARKING & SIGNPOSTING NOTES

- ALL PAVEMENT MARKINGS, CHEVRONS AND REFLECTORS ARE TO BE IN ACCORDANCE WITH RMS QA SPECIFICATION R141 & R142, CURRENT RMS DELINEATION GUIDELINES, AUSTRALIAN STANDARDS AND RMS SUPPLEMENTS.
- 2. ALL SIGNS TO BE IN ACCORDANCE WITH CURRENT AUSTRALIAN STANDARD AS 1743 ROAD SIGNS, RMS SUPPLEMENTS AND COUNCIL'S SPECIFICATIONS UNLESS STATED OTHERWISE.
- 3. ROAD SIGNS ARE SIZE 'A', UNLESS OTHERWISE SHOWN. LOCATE OUTSIDE OF CLEAR ZONES.
- 4. AUTHORIZATION FOR THE INSTALLATION OF <u>ALL</u> REGULATORY SIGNPOSTING AND LINE MARKING ILLUSTRATED ON THIS PLAN IS TO BE OBTAINED FROM RMS, TRAFFIC ENGINEERING SERVICES.

 REGULATORY SIGNPOSTING AND LINE MARKING SHOWN ON THESE PLANS ARE <u>NOT APPROVED</u> FOR INSTALLATION.
- 5. SHARED PATH IS TO BE DELINEATED AND SIGNPOSTED TO COMPLY WITH CURRENT PUBLISHED NSW BICYCLE GUIDELINES AND SHOULD INCLUDE THE INSTALLATION OF PEDESTRIAN AND CYCLE PAVEMENT SYMBOLS IN ACCORDANCE WITH AUSTRALIAN STANDARDS PART 9 BICYCLE FACILITIES.
- 6. ALL NEW PAVEMENT MARKINGS ARE TO BE INSTALLED IN WHITE REFLECTIVE, THERMOPLASTIC PAINT.
- 7. THE SLOPE FACE OF SF KERB ARE TO BE PAINTED WHITE (E6 LINE) IN LIEU OF AN E3 EDGE LINE. YELLOW REFLECTIVE PAVEMENT MARKERS TO BE PLACED ON PAVEMENT @ 6.0m SPACINGS ADJACENT TO THE SF KERB.
- 8. RE-MARK EXISTING PAVEMENT MARKING AS DIRECTED BY THE SUPERINTENDENT/PROJECT
- 9. PAVEMENT MARKINGS THAT FORM NO PART OF THE FINAL WORKS ARE TO BE REMOVED BY WATER BLASTING OR OTHER METHOD AS APPROVED BY THE SUPERINTENDENT/PROJECT MANAGER.
- 10. ALL MEASUREMENTS ARE IN METRES UNLESS SHOWN OTHERWISE. KERBSIDE LANE WIDTH MEASURED FROM FACE OF KERB. NO INFORMATION IS TO BE SCALED FROM THESE DRAWINGS.
- 11. UTILITY INFORMATION SHOWN ON THESE PLANS IS BASED ON:
 - DIAL BEFORE YOU DIG PLANS
 - MX SURVEY MODEL 'SURVEY EXPLORERS 110157'
- 12. UTILITY INFORMATION SHOWN ON THE PLANS DOES NOT DEPICT ANY MORE THAN THE PRESENCE OF A SERVICE, BASED ON AVAILABLE DOCUMENTARY EVIDENCE. THE PRESENCE OF A UTILITY SERVICE, ITS SIZE AND LOCATION SHOULD BE CONFIRMED BY FIELD INSPECTION, PRIOR TO THE COMMENCEMENT OF ROADWORKS AND THE RELEVANT UTILITY PLANS OBTAINED BY DIALLING PH 1100 OR FAX 1300 652 077 (DIAL BEFORE YOU DIG). CAUTION SHOULD BE EXERCISED WHEN WORKING IN THE VICINITY OF ALL UTILITY SERVICES.


PAVEMENT MARKING & SIGNPOSTING SUPPLEMENTARY DRAWINGS


STANDARD KERB AND GUTTER SHAPES	MD.R15.A01.A.1
KERB RAMPS	MD.R173.B01.A
TYPICAL APPLICATION OF KERB RAMPS AT INTERSECTIONS	MD.R173.A01.A
PAVEMENT LINEMARKING & DIMENSIONS	MD.R60.A01.A
SECTION 16 - GUIDE POSTS & DELINEATION OF SAFETY BARRIERS	RMS DELINEATION GUIDE
RMS TCS PLAN - SOLDIERS PARADE (TCS 4632)	DS2014 / 004990
RMS TCS PLAN - MACDONALD ROAD REALIGNMENT (TCS 4633)	DS2014 / 004991
KERBS AND GUTTERS (PENRITH CITY COUNCIL)	SD1003/1


LINE MARKING SCHEDULE


LINE MARKING SCHEDULE								
CODE	USE	STYLE	COLOUR & TYPE					
TURNIN	NG, STOP & GIVE WAY LINES							
TF	STOP LINE AT TRAFFIC SIGNALS	0.30m (<80km/h)	REFLECTORISED WHITE					
T1	DEFINES TURNING PATHS AT COMPLEX INTERSECTIONS	0.60 0.10m	REFLECTORISED WHITE					
BICYCLE LANE								
S4	BICYCLE LANE SEPARATION LINE FOR OFF-ROAD BIKE PATH	↓ 0.10m ←	REFLECTORISED WHITE					
S 5	BICYCLE LANE SEPARATION LINE FOR OFF-ROAD BIKE PATH (STRAIGHT SECTIONS)	-11-3-11- 	REFLECTORISED WHITE					
C4	BICYCLE LANE CONTINUITY LINE	1 3 1	REFLECTORISED WHITE					
E7	BICYCLE EDGE LINE FOR OFF-ROAD BIKE PATHS & SHARED PATHS	0.10m	REFLECTORISED WHITE					
LANE L	INES							
L1	LANE LINE ON MULTI LANE ROAD INCLUDING MOTORWAYS & DUAL CARRIAGEWAYS	0.10m	REFLECTORISED WHITE TYPE 'W' PAVEMENT MARKERS MONO-DIRECTIONAL REFLECTIVE WHITE					
CONTIN	NUITY LINE							
C1	DEFINES EDGES OF THROUGH CARRIAGEWAY TO TURNING LANE, FREEWAY RAMP, BUS BAY AND START OR FINISH OF AUXILIARY LANE	0.15m	REFLECTORISED WHITE TYPE 'W' PAVEMENT MARKERS MONO-DIRECTIONAL REFLECTIVE YELLOW					
KERBS	IDE PARKING RESTRICTION L	INES						
C2	KERBSIDE LINEMARKING FOR CLEARWAY RESTRICTIONS	13 13 3 13 1 1 1 1 1 1 1 1 1 1 1 1 1 1	REFLECTORISED WHITE					
C3	KERBSIDE LINEMARKING FOR NO STOPPING RESTRICTIONS	0.10m	REFLECTORISED WHITE					
C4	BICYCLE LANE CONTINUITY LINE	-11+3-11+ 	REFLECTORISED WHITE					
EDGE LINES								
E1	LEFT HAND EDGE LINE ON GENERAL PURPOSE ROAD	0.15m →	REFLECTORISED WHITE					
E3	RIGHT HAND EDGE ON DIVIDED CARRIAGEWAY	0.15m -	REFLECTORISED WHITE					
E4	OUTLINE OF TRAFFIC ISLAND OR FREEWAY RAMP GORE	→ 0.15m	REFLECTORISED WHITE					
PEDESTRIAN CROSS WALK LINES								
PCW	PEDESTRIAN CROSS WALK LINES	0.15m 0.3	REFLECTORISED WHITE					
		L						

30														_			_
	DRAWING FILE LOCATION / NAME J/110157RI01_CDR - Concept Plans/Part 1 - Explorers Way\110157-CDR-601.dwg			DESIGN LO	OT CODE	E DESIGN MODEL FILE(S) USED FOR DOCUMENTATION OF THIS DRAWING		PLOT DATE / TIME 14/08/2015 4:52:29 PM		PLOT BY CLIENT rsilva		.	PENRITH CITY COUNG MR629 ERSKINE PAR	K ROAD		А3	
0	EXTERNAL REFERENCE FILES	REV	DATE	AMENDMENT / REVISION DESCRIPTION	WVR No.	APPROVAL	SCALES ON A3 SIZE DRAWING	DRAWINGS / DESIGN PREPARED BY	TITLE	NAME	DATE		Transport	EXPLORERS W.	AY PROPOSED		
.,		Α 2	23/06/2015	FINAL ISSUE FOR STAKEHOLDER REVIEW		P.S.		J. WYNDHAM PRINCE	DRAWN	R.C							
15		В 1	14/08/2015	FINAL ISSUE	1	P.S.			DRG CHECK			NSW	Roads & Maritime Services	SIGNPOSTING 8	& LINEMARKING		
9					1			CONSULTING CIVIL INFRASTRUCTURE ENGINEERS & PROJECT MANAGERS	DESIGN	R.A.S		337 miles (mile)		GENERAL NOTES & S		SHEET 1 OF	F 6
_					1			LEVEL 1, 77 UNION ROAD	DESIGN CHECK	P.S		PREPARED FOR		RMS REGISTRATION No. DS	2015/002541		PART 1
2					1		CO-ORDINATE SYSTEM HEIGHT DATUM	PENRITH NSW 2750	DESIGN MNGR					ISSUE STATUS	EDMS No.		ISSUE
0							MGA ZONE 56 AHD	P (02) 4720 3000 E jwp@jwprince.com.au	PROJECT MNGR					10002 0111100	ESMO No.	CDR-601	B
_															© Roads	and Maritime Ser	rvices

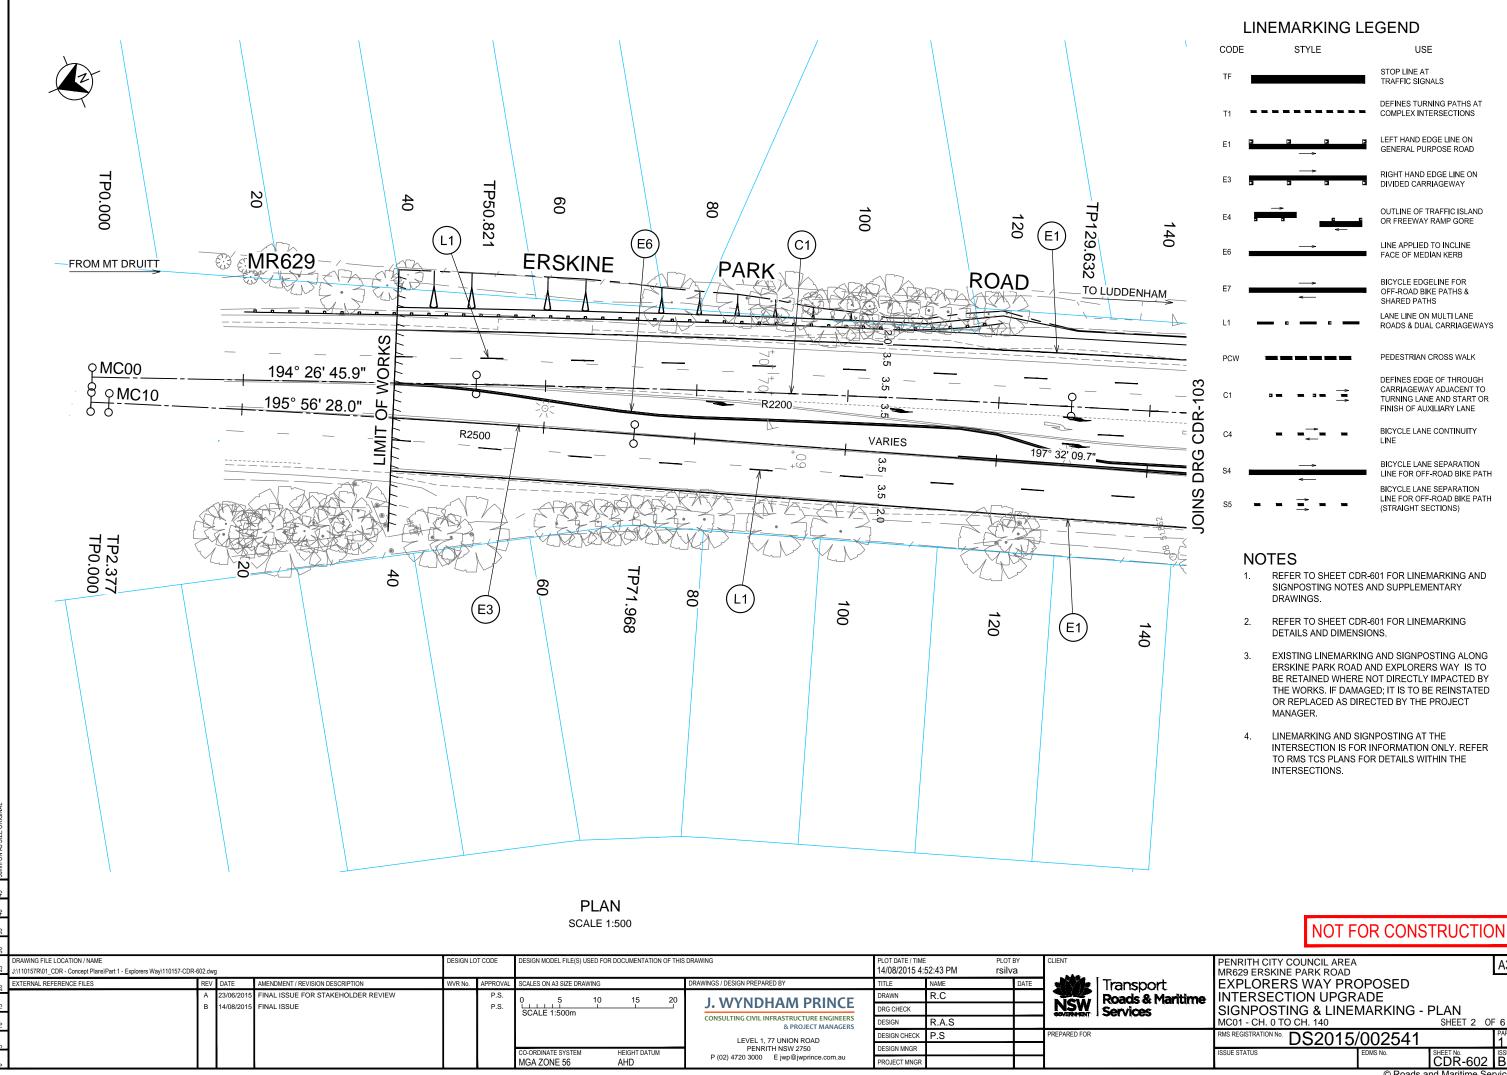


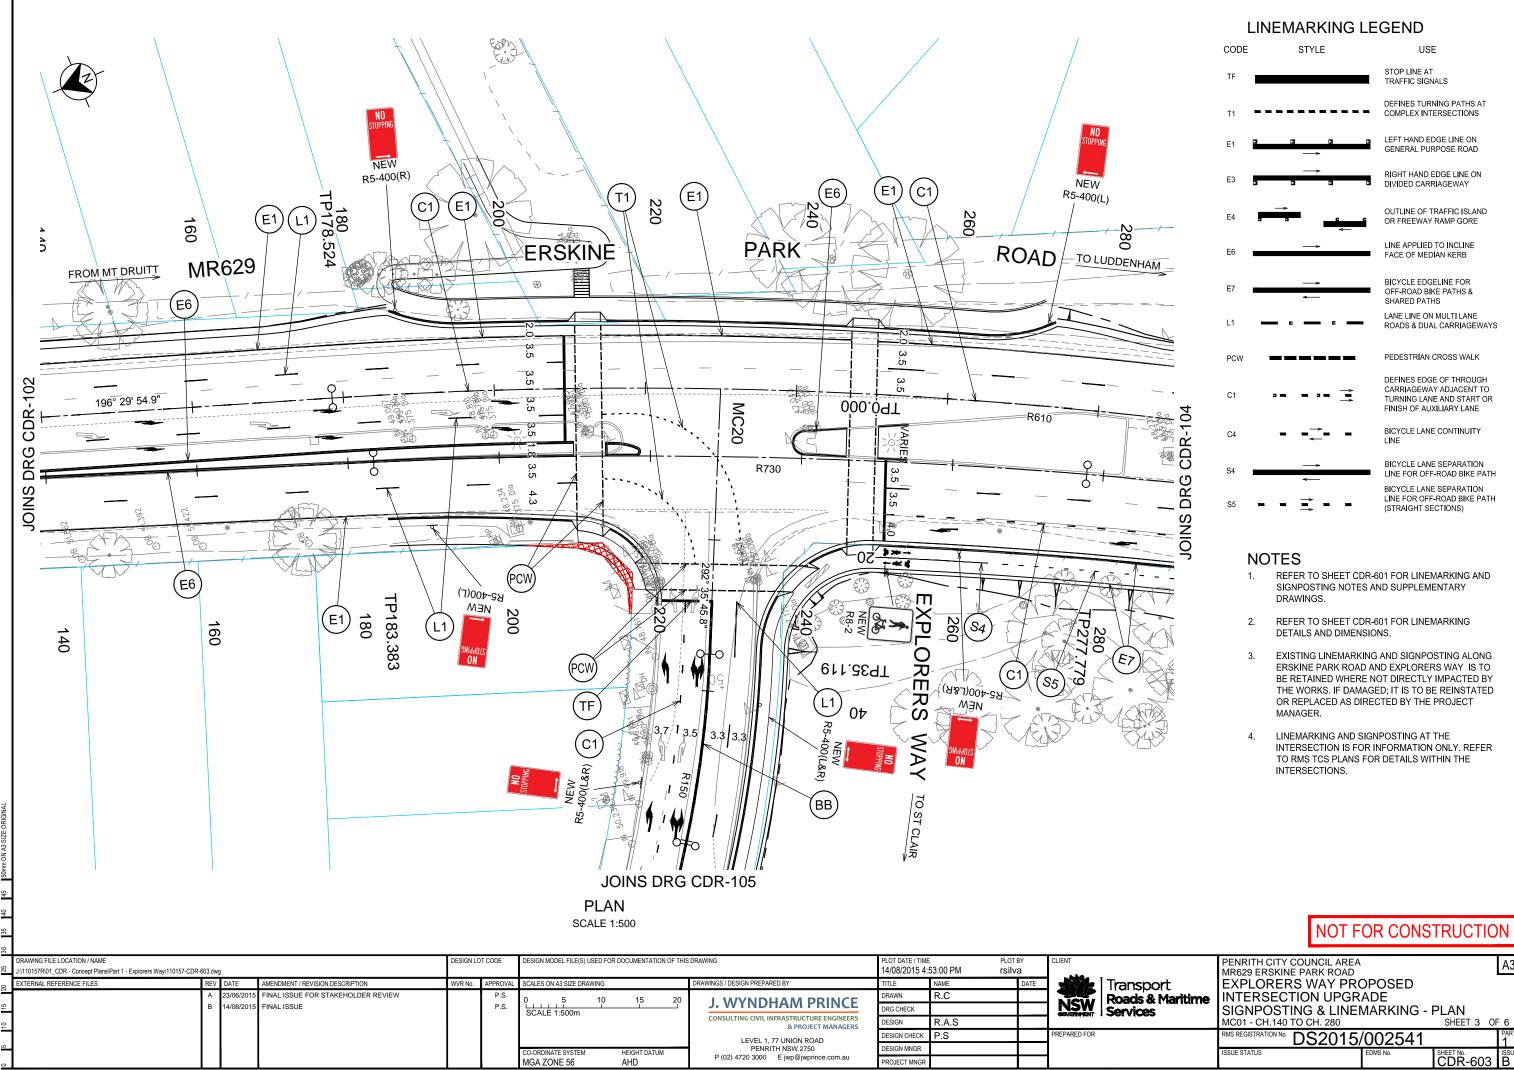

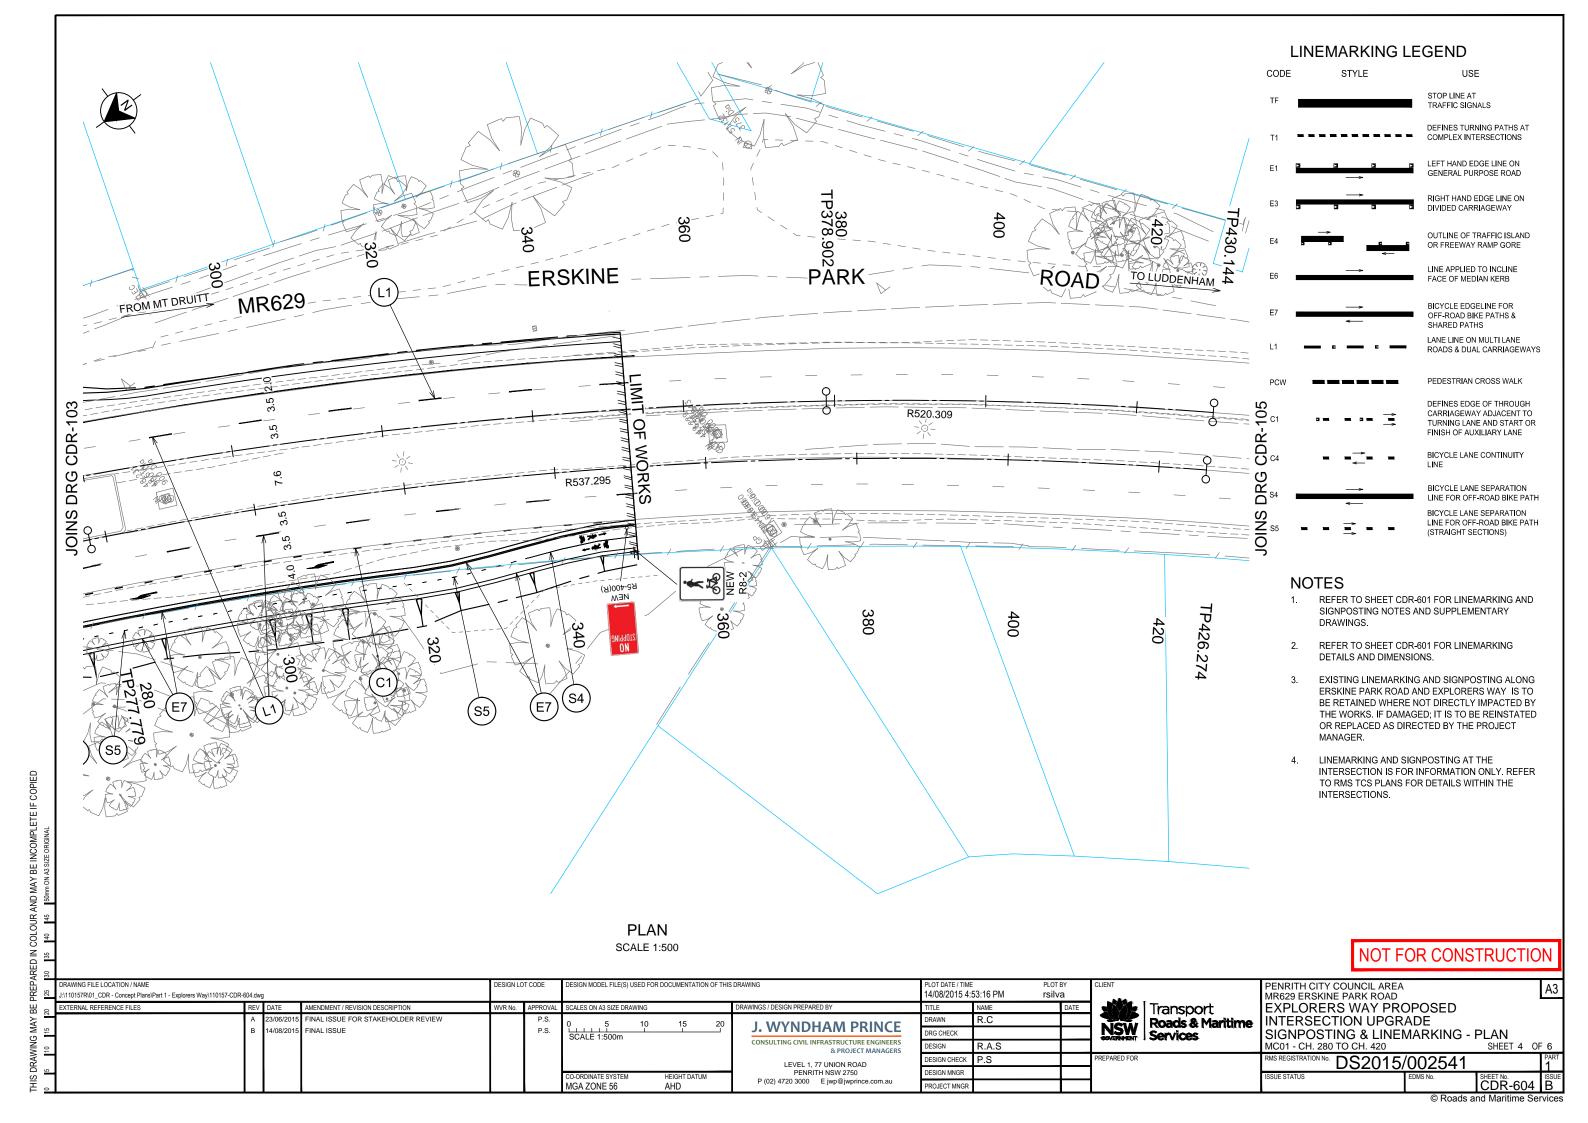

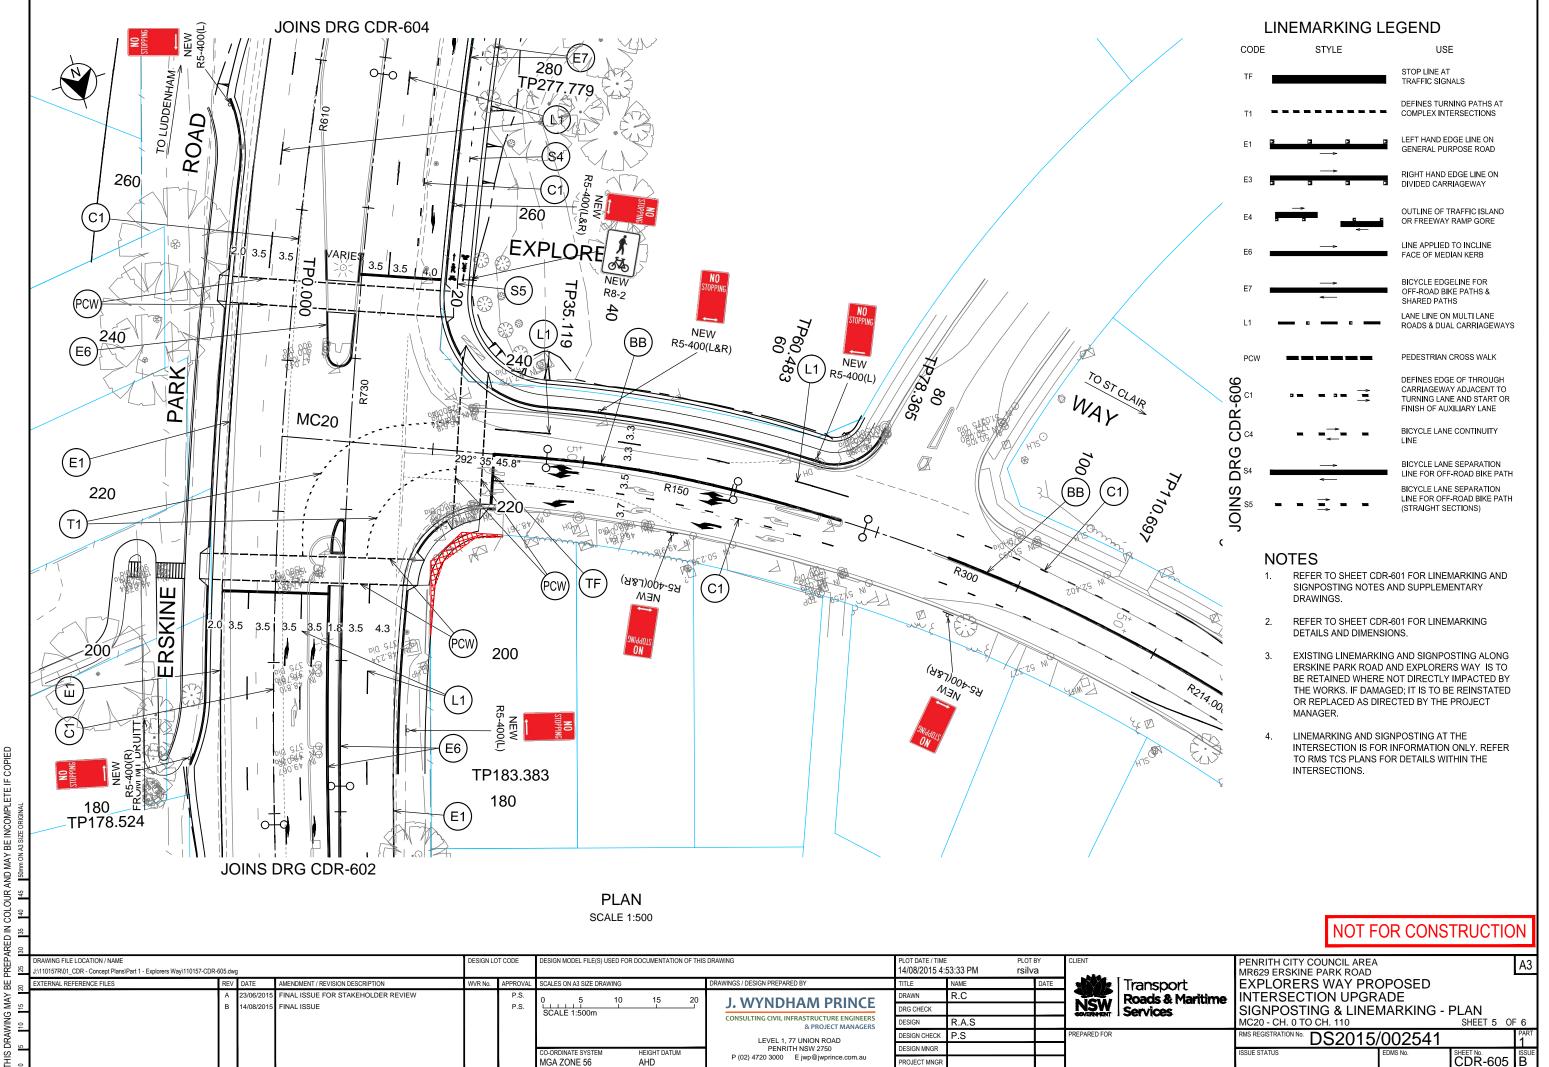



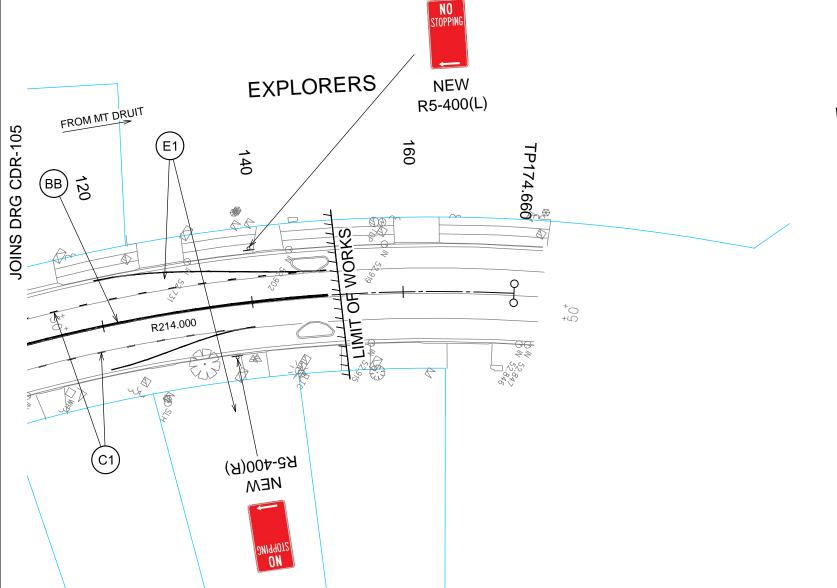

WAY

LINEMARKING LEGEND

-		CLITE
CODE	STYLE	USE
TF		STOP LINE AT TRAFFIC SIGNALS
T1 1		DEFINES TURNING PATHS AT COMPLEX INTERSECTIONS
E1 [<u> </u>	LEFT HAND EDGE LINE ON GENERAL PURPOSE ROAD
E3	→ 3 3 5 5	RIGHT HAND EDGE LINE ON DIVIDED CARRIAGEWAY
E4	-	OUTLINE OF TRAFFIC ISLAND OR FREEWAY RAMP GORE
E6 ∎	→	LINE APPLIED TO INCLINE FACE OF MEDIAN KERB
E7 ∎	→	BICYCLE EDGELINE FOR OFF-ROAD BIKE PATHS & SHARED PATHS
L1		LANE LINE ON MULTI LANE ROADS & DUAL CARRIAGEWAYS
PCW		PEDESTRIAN CROSS WALK
C1	:= = := ⇒	DEFINES EDGE OF THROUGH CARRIAGEWAY ADJACENT TO TURNING LANE AND START OR FINISH OF AUXILIARY LANE
C4	= = = =	BICYCLE LANE CONTINUITY LINE
S4 •	→	BICYCLE LANE SEPARATION LINE FOR OFF-ROAD BIKE PATH
S5	📑	BICYCLE LANE SEPARATION LINE FOR OFF-ROAD BIKE PATH (STRAIGHT SECTIONS)

NOTES

TO ST CLAIR

- REFER TO SHEET CDR-601 FOR LINEMARKING AND SIGNPOSTING NOTES AND SUPPLEMENTARY DRAWINGS.
- 2. REFER TO SHEET CDR-601 FOR LINEMARKING DETAILS AND DIMENSIONS.
- 3. EXISTING LINEMARKING AND SIGNPOSTING ALONG ERSKINE PARK ROAD AND EXPLORERS WAY IS TO BE RETAINED WHERE NOT DIRECTLY IMPACTED BY THE WORKS. IF DAMAGED; IT IS TO BE REINSTATED OR REPLACED AS DIRECTED BY THE PROJECT MANAGER.
- . LINEMARKING AND SIGNPOSTING AT THE INTERSECTION IS FOR INFORMATION ONLY. REFER TO RMS TCS PLANS FOR DETAILS WITHIN THE INTERSECTIONS.

PLAN SCALE 1:500

NOT FOR CONSTRUCTION

PLOT DATE / TIME 14/08/2015 4:53:50 PM PENRITH CITY COUNCIL AREA MR629 ERSKINE PARK ROAD EXPLORERS WAY PROPOSED rsilva .110157R\01_CDR - Concept Plans\Part 1 - Explorers Way\110157-CDR-606.dwg Transport FINAL ISSUE FOR STAKEHOLDER REVIEW INTERSECTION UPGRADE R C Roads & Maritime 0 5 SCALE 1:500m J. WYNDHAM PRINCE NSW FINAL ISSUE P.S. SIGNPOSTING & LINEMARKING - PLAN MC20 - CH. 110 TO CH.180 SHEET 6 OF 6 Services CONSULTING CIVIL INFRASTRUCTURE ENGINEERS R.A.S DESIGN & PROJECT MANAGERS DESIGN CHECK P.S REPARED FOR DS2015/002541 LEVEL 1, 77 UNION ROAD PENRITH NSW 2750 DESIGN MNGR CO-ORDINATE SYSTEM MGA ZONE 56 ISSUE STATUS HEIGHT DATUM P (02) 4720 3000 E jwp@jwprince.com.au AHD

IIS DRAWING MAY BE PREPARED IN COLOUR

© Roads and Maritime Services